

**US Army Corps
of Engineers**
Louisville District ®

Public Notice

Public Notice No.
LRL-2013-499-jea

Open Date:
31 Oct 2013

Close Date:
2 Dec 2013

Please address all comments and inquiries to:
U.S. Army Corps of Engineers, Louisville District
ATTN: Ms. Jane Archer, CELRL-OP-FS, Rm 752
P.O. Box 59
Louisville, Kentucky 40201-0059

Phone: (502) 315-6682

This notice announces an application submitted for a Department of the Army (DA) Permit, subject to Section 10 of the Rivers and Harbors Act of 1899 and Section 404 of the Clean Water Act (CWA).

APPLICANT: Martin P. Riche
1292 Cherokee Road
Louisville, Kentucky 40204

AGENT: River Trends, LLC
4007 Fox Meadow Way
Prospect, Kentucky 40059

LOCATION: Left Bank of the Ohio River, Mile 496.5, Prospect,
Jefferson County, Kentucky
Latitude: 38° 19' 20" N
Longitude: 85° 38' 50" W
7.5 Minute Quad: Jeffersonville, Kentucky

PURPOSE: To extend the property to eliminate an eddy that
scours the shoreline and to eliminate drift
accumulation.

DESCRIPTION OF WORK: The applicant proposes to retain appropriately 60 cubic yards of rock filled gabion baskets and 3-14-inch diameter steel mooring poles. The maximum riverward extension of the gabion baskets at Normal Pool, 420 feet Ohio River Datum, is approximately 42.7 feet and the maximum riverward extension of the mooring poles with boating vessel is approximately 81.8 feet. This work was completed prior to receiving authorization from the Corps.

AVOIDANCE, MINIMIZATION, AND MITIGATION MEASURES: The applicant indicates there is no alternative to avoid the placement of fill material into the "waters of the United States" occurring on the site.

The applicant proposes no mitigation.

It is noted that this proposed mitigation plan or lack thereof is open to comment and subject to change. The Corps will make a determination of appropriate mitigation, upon review of all submitted information.

REVIEW PROCEDURES: A DA Permit cannot be issued if any legally required Federal, State, or local authorization or certification is denied. A DA permit, if otherwise warranted, will not be issued until a State of Kentucky Water Quality Certification or waiver is on file at this office. In order to comply with Section 401 of the Clean Water Act, the applicant must apply for State certification from the Kentucky Energy and Environment Cabinet Division of Water (KDOW).

Copies of this notice are sent to the appropriate Federal and State Fish and Wildlife Agencies. Their views and comments are solicited in accordance with the Fish and Wildlife Coordination Act of 1956. Based on available information, the proposed activity will not destroy or endanger any Federally-listed threatened or endangered species or their critical habitats, as identified under the Endangered Species Act, and therefore, initiation of formal consultation procedures with the U.S. Fish and Wildlife Service is not planned at this time.

Any person may request, in writing, within the comment period specified in this notice, that a public hearing be held to consider this application. A request for a public hearing must state the specific interest, which might be damaged by issuance of the DA Permit.

The National Register of Historic Places has been examined, and it has been determined that there are no properties currently listed on the Register which have been directly affected by the work. If we are made aware, as a result of comments received in response to this notice, or by other means, of specific archaeological, scientific, prehistorical, or historical sites or structures which might be affected by the proposed work, the District Engineer will immediately take the appropriate action necessary pursuant to the National Historic Preservation Act of 1966 - Public Law 89-665 as amended (including Public Law 96-515).

The decision whether to issue a permit will be based on an evaluation of the probable impact of the proposed activity on the public interest. That decision will reflect the national concern for both protection and utilization of important resources. The benefits which reasonably may be expected to accrue from the proposal must be balanced against its reasonably foreseeable detriments. All factors which may be relevant to the proposal will be considered; among those are conservation, economics, aesthetic values, general environmental concerns, historic values, fish and wildlife values, flood damage prevention, land use, navigation, recreation, water supply, water quality, energy needs, safety, food production, and in general, the needs and welfare of the public. In addition, the evaluation of the impact of the activity on the public interest will include application of the guidelines (40 CFR Part 230) promulgated by the Administrator, United States Environmental Protection Agency, under authority of Section 404(b) of the CWA.

The Corps of Engineers is soliciting comments from the public; Federal, State, and local agencies and officials; Indian tribes; and other

interested parties in order to consider and evaluate the impacts of this proposed activity. It is presumed that all interested parties and agencies will wish to respond; therefore, a lack of response will be interpreted as meaning that there is no objection to the proposed project. Any comments received will be considered by the Corps of Engineers to determine whether to issue, modify, condition or deny a permit for this proposal. To make this decision, comments are used to assess impacts on endangered species, historic properties, water quality, general environmental effects, and the other public interest factors listed above. Comments are used in the preparation of an Environmental Assessment and/or an Environmental Impact Statement pursuant to the National Environmental Policy Act. Comments are also used to determine the need for a public hearing and to determine the overall public interest of the proposed activity.

Written statements received in this office on or before the closing date will become a part of the official record and will be considered in the determination on this permit request. Any objections which are received during this period will be forwarded to the applicant for possible resolution before the determination is made whether to issue or deny the requested DA Permit. A permit will be granted unless its issuance is found to be contrary to the public interest.

Information pertaining to this application is available for public examination during normal business hours upon prior request. Drawings are available on Louisville District's Internet site at <http://www.lrl.usace.army.mil/Missions/Regulatory.aspx>. All comments regarding this proposal should be addressed to Ms. Jane Archer, CELRL-OP-FN at the address noted above and should refer to the Public Notice Number LRL-2013-499-jea.

If you desire to submit your comments by email, you must comply with the following:

a) In the subject line of your email, type in **ONLY** the Public Notice ID No. LRL-2013-499-jea.


Example:

Subject: LRL-2013-499-jea

b) Provide your physical mailing address and telephone number.

c) Send your email to: lrl.regulatorypubliccomment@usace.army.mil.

d) If you are sending attachments greater than 1 Mb in size with your email, you must send a hard copy (CD or paper) to the Corps' physical address as well.

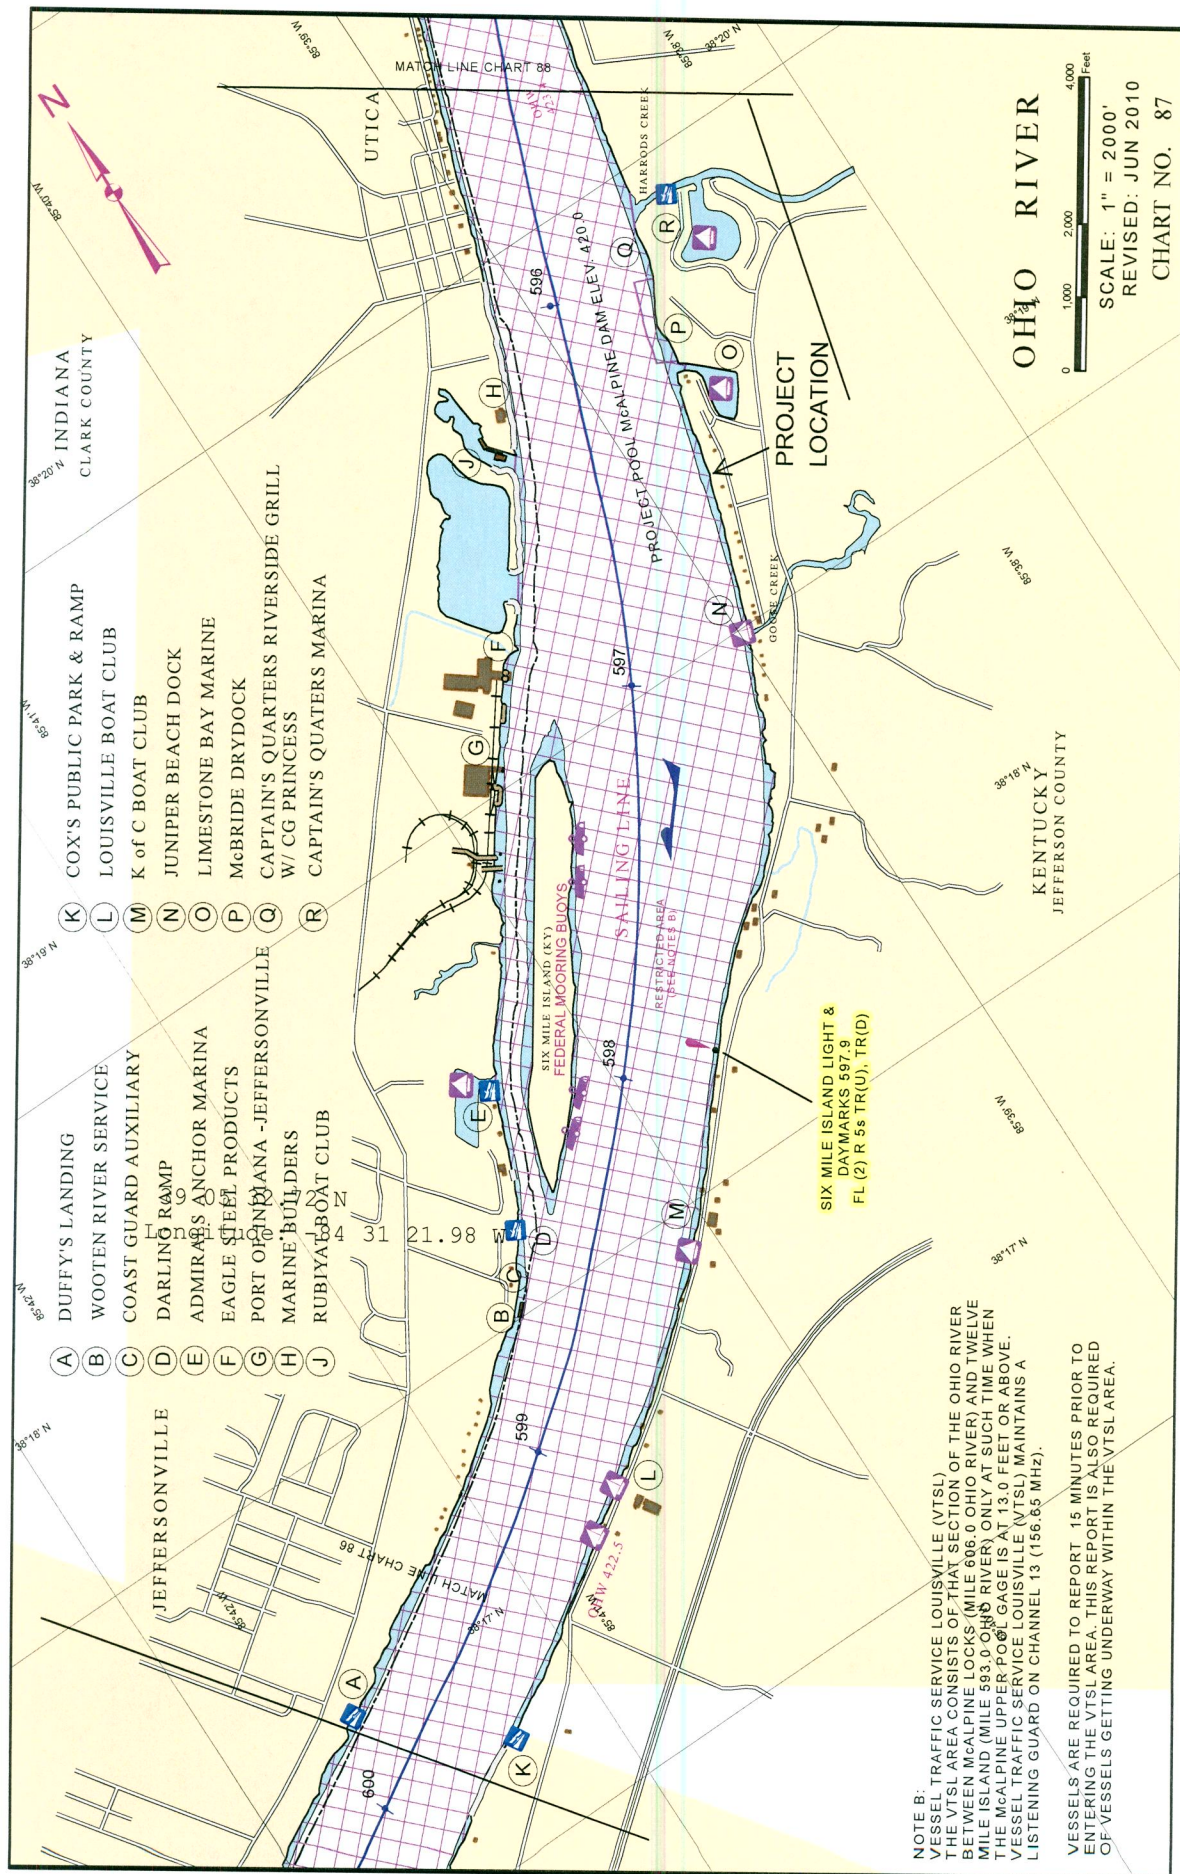


LRL-2013-499-jea
5617 Juniper Beach Road
Prospect, Kentucky Project
Ohio River Mile 595.5

FIGURE 1

OHIO RIVER MILE +596.5 (JUNIPER BEACH DOCKS)
 PROJECT POOL MCALPINE DAM ELEV. = 420'
 ORDINARY HIGH WATER MARK = 422.8'

WATER FLOW DIRECTION

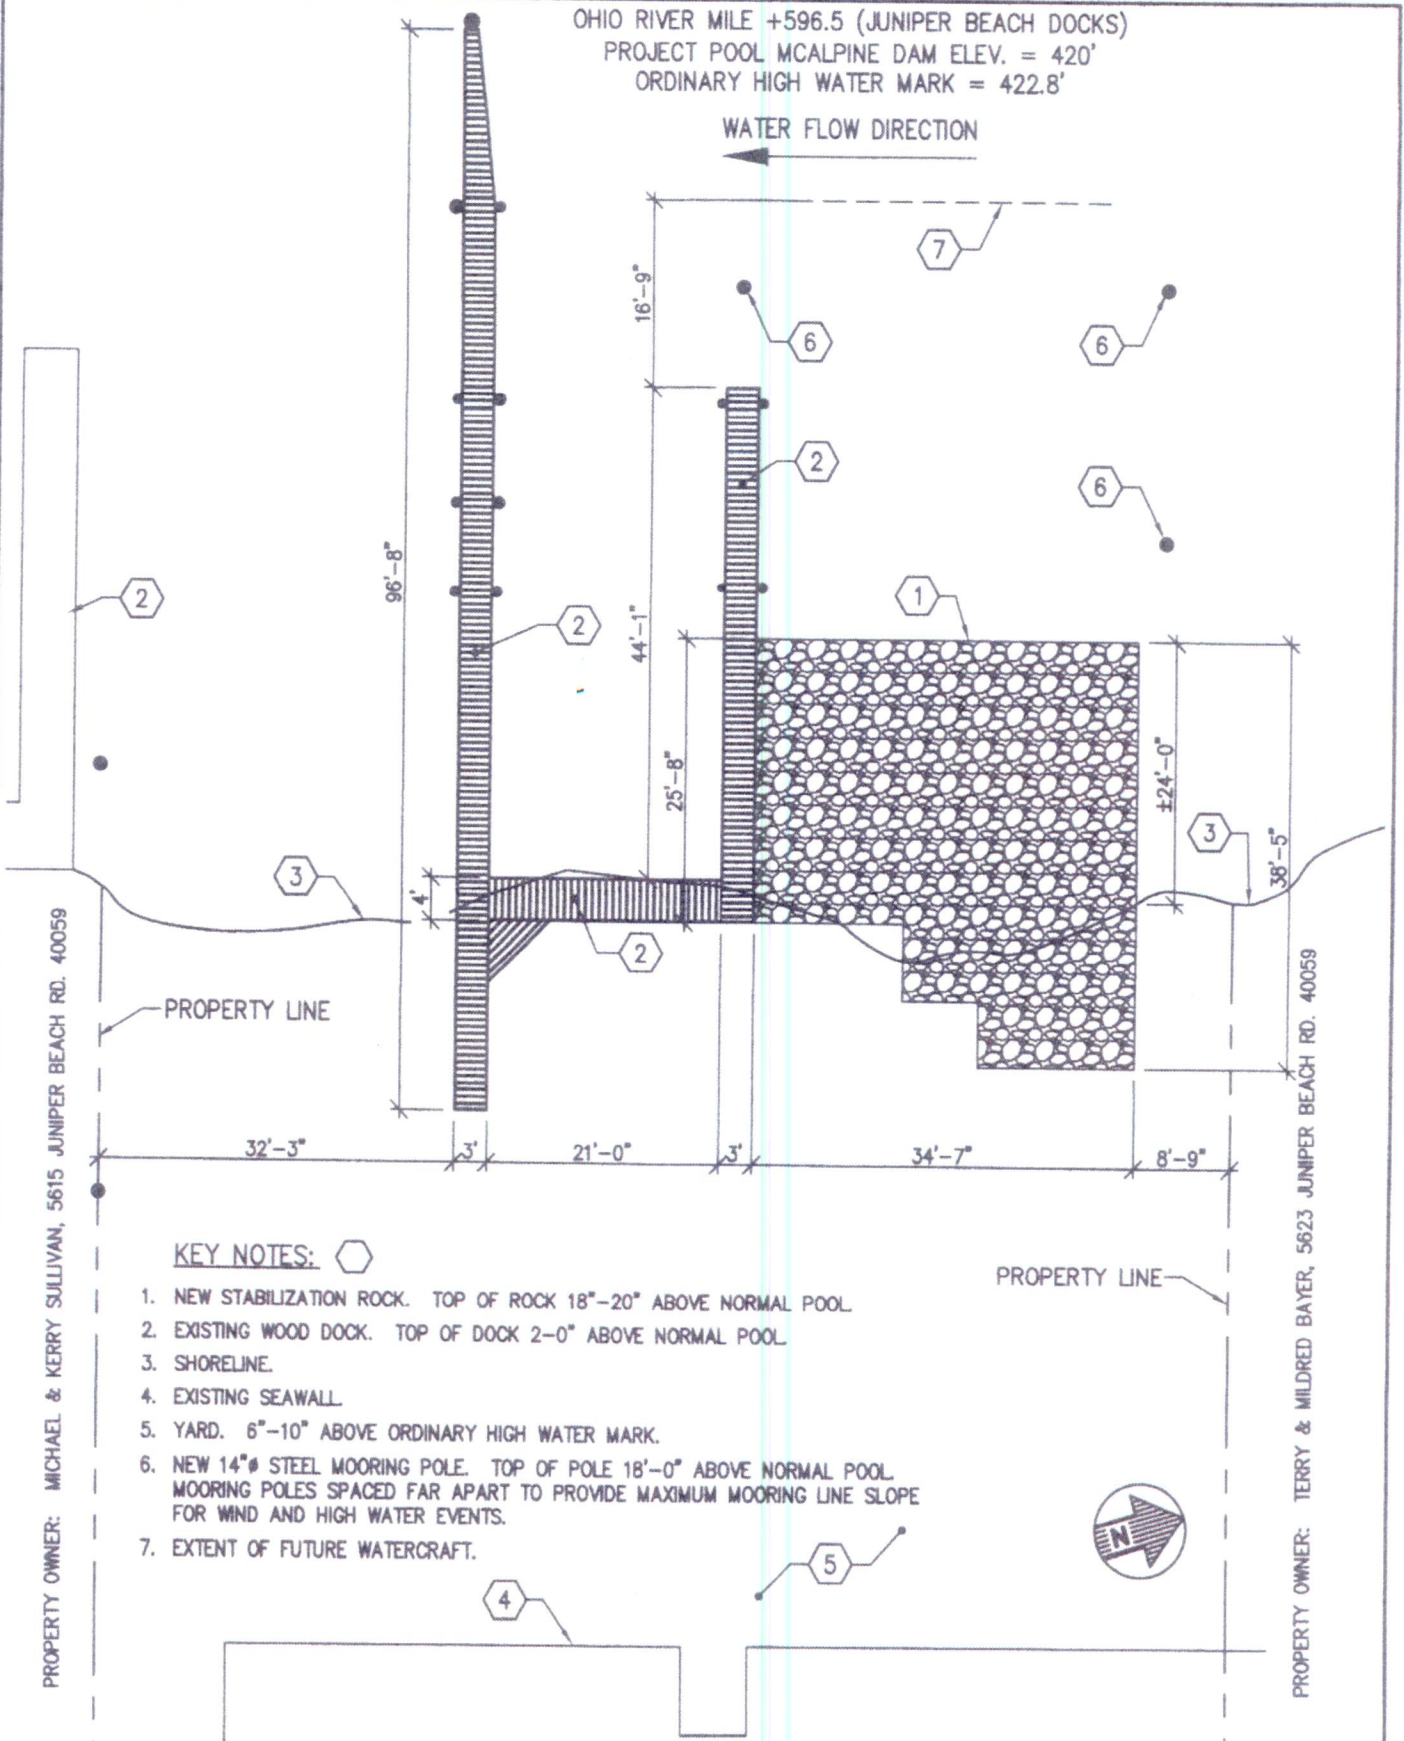

KEY NOTES:


1. NEW STABILIZATION ROCK. TOP OF ROCK 18"-20" ABOVE NORMAL POOL.
2. EXISTING WOOD DOCK. TOP OF DOCK 2'-0" ABOVE NORMAL POOL.
3. SHORELINE.
4. EXISTING SEAWALL.
5. YARD. 6"-10" ABOVE ORDINARY HIGH WATER MARK.
6. NEW 14"Ø STEEL MOORING POLE. TOP OF POLE 18'-0" ABOVE NORMAL POOL. MOORING POLES SPACED FAR APART TO PROVIDE MAXIMUM MOORING LINE SLOPE FOR WIND AND HIGH WATER EVENTS.
7. EXTENT OF FUTURE WATERCRAFT.

PROJECT: 5617 JUNIPER BEACH ROAD
 RIVERBANK STABILIZATION & BOAT DOCK PROJECT
 OHIO RIVER, MILE 596.5
 CITY OF PROSPECT, JEFFERSON COUNTY, KENTUCKY

TITLE: OVERALL SITE PLAN
 FIGURE 2
 ISSUE: PERMIT APPLICATION

DATE: 10/07/13
 SCALE: 1/16" = 1'-0"
 DRAWN BY: B.T.G.

DRAWING NUMBER:
 2
 2 OF 3

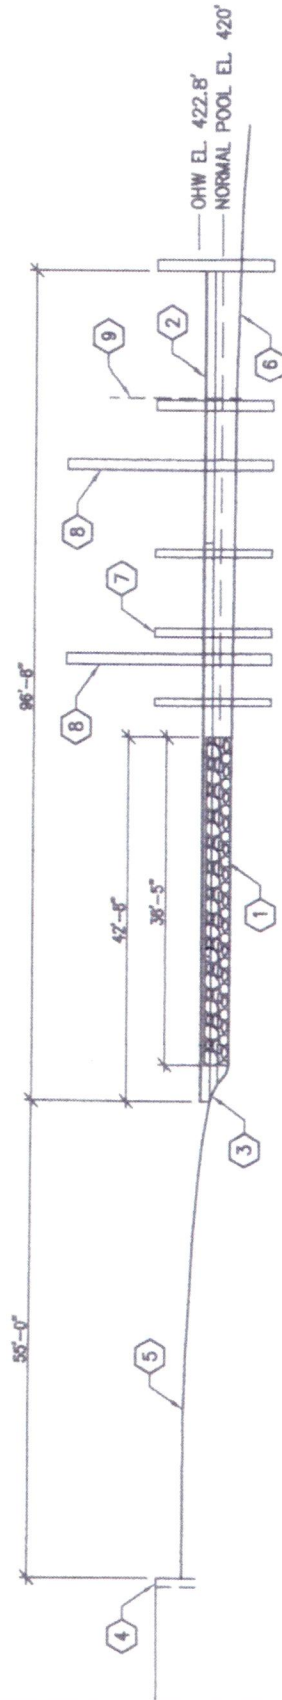

KEY NOTES: 

1. NEW STABILIZATION ROCK. TOP OF ROCK 18"-20" ABOVE NORMAL POOL.
2. EXISTING WOOD DOCK. TOP OF DOCK 2'-0" ABOVE NORMAL POOL.
3. SHORELINE.
4. EXISTING SEAWALL.
5. YARD. 6"-10" ABOVE ORDINARY HIGH WATER MARK.
6. APPROXIMATE RIVER BOTTOM.
7. EXISTING WOOD PILE (TYPICAL).
8. NEW 14"# STEEL MOORING POLE. TOP OF POLE 18'-0" ABOVE NORMAL POOL.
9. EXTENT OF FUTURE WATERCRAFT.

PROJECT: **PROPOSED 5617 JUNIPER BEACH ROAD**
RIVERBANK STABILIZATION & BOAT DOCK PROJECT
 OHIO RIVER, MILE 596.5
 CITY OF PROSPECT, JEFFERSON COUNTY, KENTUCKY

TITLE: **TYPICAL SECTION**
FIGURE 3
 ISSUE: **PERMIT APPLICATION**

DATE: **10/07/13**
 SCALE: **NONE**
 DRAWN BY: **B.T.G.**

DRAWING NUMBER:
3
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